


RCP & LIFE SAFETY NOTES

- All new internal corridor and room door sets are to be minimum of 950mm wide designed to give a clear dimension from face of open door leaf to opposite door jam of 800mm - Building Regulations Part M Compliance.
- New accessable toilet door must be 1000mm overall set Other customer/staff toilets entrance door sets to be a minimum of 950mm wide overall.
- FD30 S VP SC -30min fire door construction (FD30) with intumescent seals including smoke stops (S) with Vision panels (VP and door closure (SC). FD60 doors to be used where stated.
- Vision panels in fire doors to be constructed in pyrobel 12 or swiss flam clear glazing to give 30min protection. Vision panels to be approx 1450mm x 150mm wide extending to within 300mm of door top and 300mm of door bottom and inset by 225mm from open side.
- Doors to kitchen to have high level vision panels with 500mm stainless steel kickplates to base and double sing hinge.
- Door leading from public spaces to back of house to be fitted with electronic access kepypad.
- All fire doors to have self closure devices with 'fire door kept shut' signs fitted to both sides.
- All fire doors not fitted with self closure devices to be fitted with 'FIRE DOOR KEEP SHUT' signage.
- Self closures must be designed to suit door weight and size, but set to an opening strength no greater than 20n.
- IRONMONGERY: Door furniture, handles, kick plates/push plates all to be stainless steel satin finish. See finishes for details.
- Door Finishes: All doors to be decorated on site with 1 coat primer and 2 coats egshell paint PT03. Architrave PT03 Final fire exit doors to be fitted with emergency release escape ironmongery to PART B Building Regulations and BS 9999. Additional last man out easy release securing device may be fitted in compliance wuth BS 9999, providing that the use is factored into clients risk assesment.

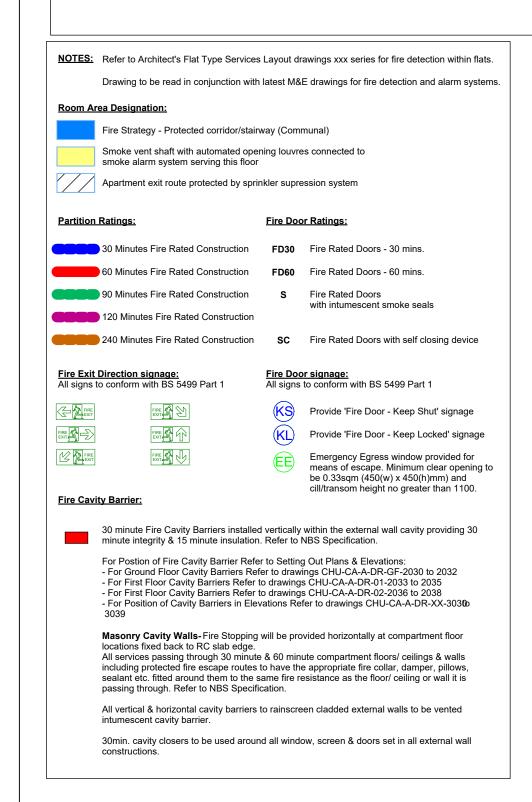


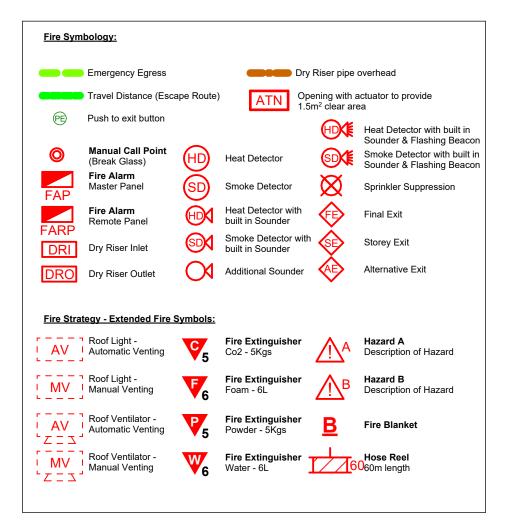

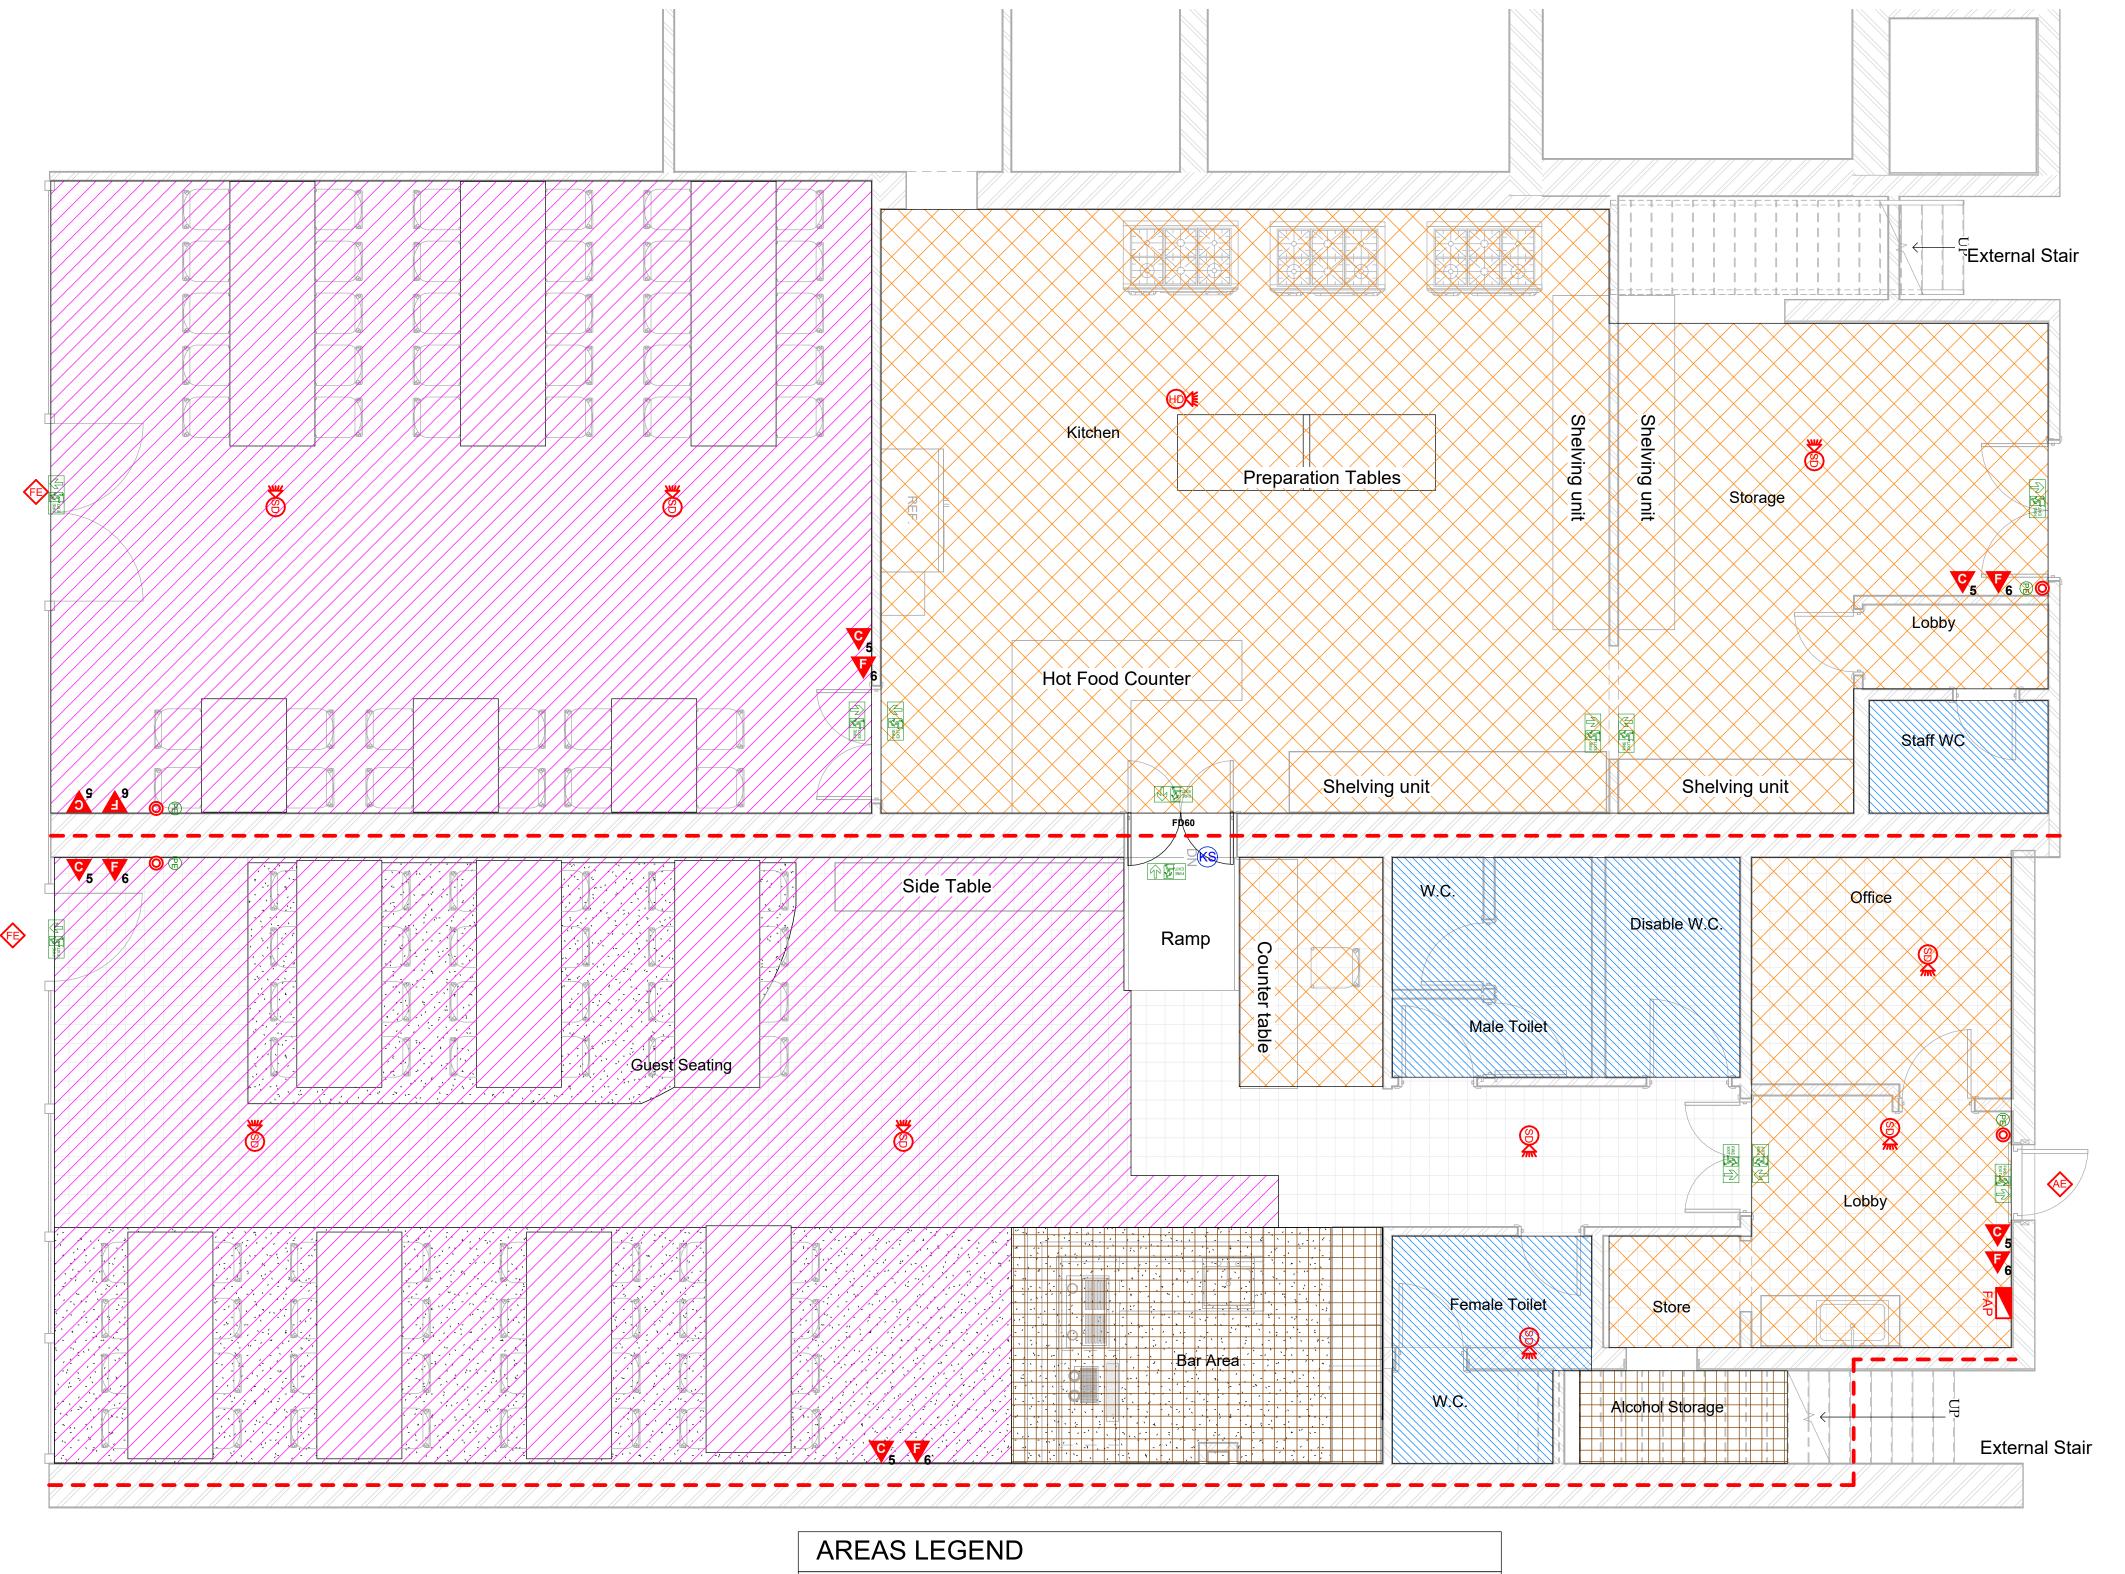

EMERGENCY LIGHTING NOTES

- All emergency lighting to be designed & installed in accordance with BSEN1838 &
- All Socket outlets to be RCD protected (Excluding till equipment Power Sockets) at the
- Fire Alarm system to be designed in accordance with British Standard 5839 Part 1 & Installed by Approved Contractor.
- All works to conform to current Landlords Fit-out requirements.
- Fire Exit Signage Design & installation must conform to British Standard 5499 part 4-2000. Ceiling to be installed on solid supports (not wire) to comply with British Standard 8290
- Any alterations to the fire alarm system will be in accordance with BS5839 Part 1
- Any alterations to the emergency lighting system will be in accordance with BS5266 Part1 All doors/counter flaps on escape routes will be readily openable without the use of a key.
- New ceilings and wall finishes will be surface spread of flame rating of Class O to circulation routes, Class 1 elsewhere, and Class 3 to small rooms.

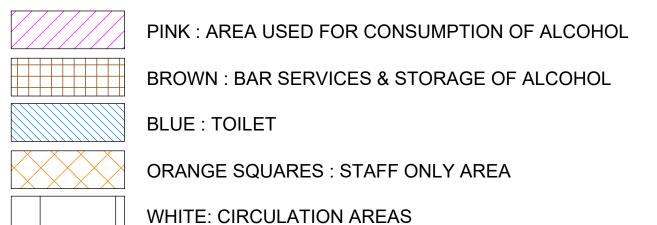

FIRE EXTINGUISHERS

- Fire fighting equipment positions are indicative and supplied by client, direct order contractor, including extinguishers, related fire action notices and action point notices.
- Photo illuminescent signage and final emergency and directional signage to

comply with BS 5499:1 2002. H&S (Safety signs and signals) regulations 1996. Main contractor to provide and fix 20mm chamfered pattress securley to

wall/parttion. Overall size 700mm x 450mm, painted to match walls.

Project: 156 Kenton Road Drawing: Ground Floor - Fire Strategy DESIGNLABS ALL I Scale: As indicated | Status: Construction Date: 31/01/2023 Dwg No : C-30.1

DESIGNLABS LONDON ARCHITECTURE / INTERIOR / MANAGEMENT / PLANNING

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the DLL in writing and DLL shall not take responsiblity for site failing to inform discrepancies.