
SIDE ELEVATION

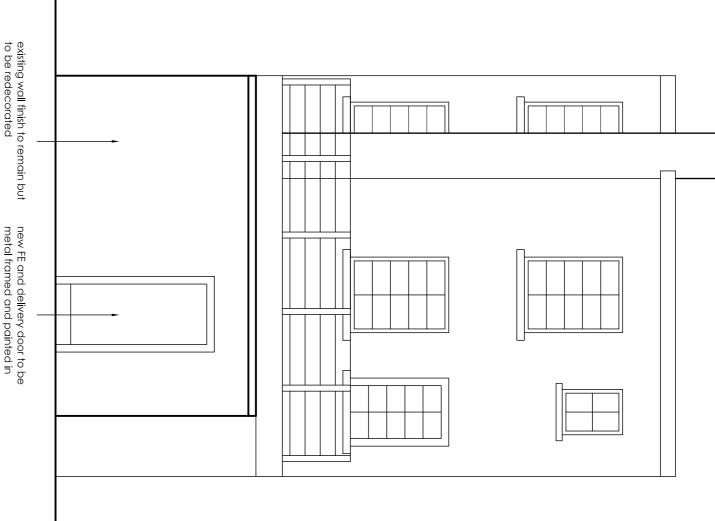

SHOPFRONT ELEVATION

LANDLORD WORKS

Service/Delivery Access

Bin

Kitchen

Delivery&FE

-Approx 2016-


903/933


chute

—1700—

Bin

GAS

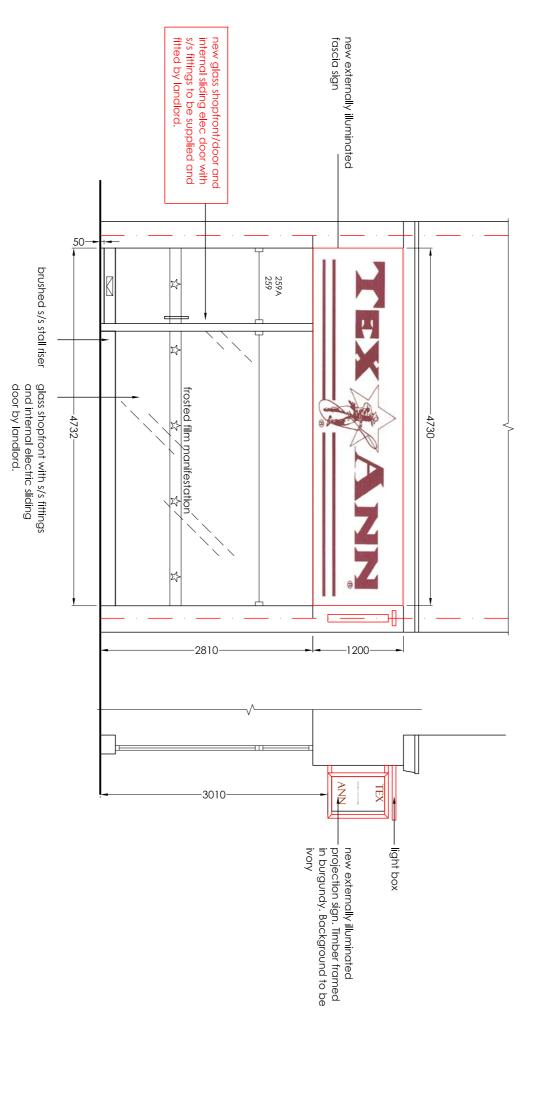

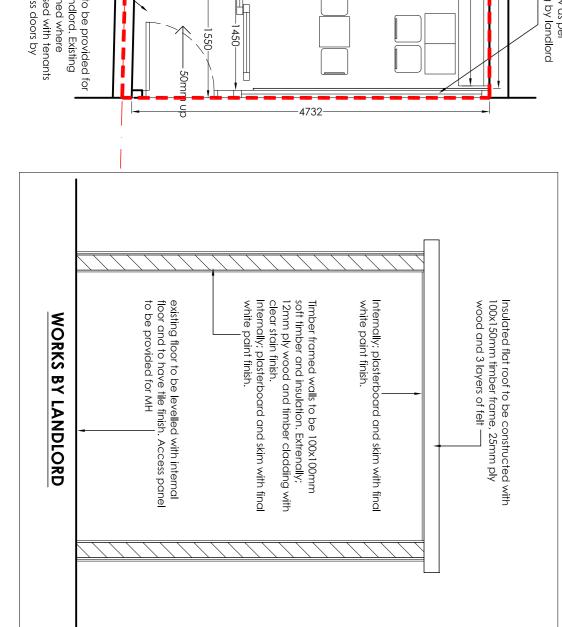

TIMBER SHED **DETAILS**

LAYOUT

DISABLE W.C SANITARY WARE FROM http://www.armitage-shanks.co.uk/comme

ALL SERVICES (WATER, ELEC AND GAS)
TO BE PROVIDED BY LANDLORD. SPEC
TO BE AGREED WITH TENANT

Scale= 1:50@A3

REAR ELEVATION

RESTAURANT AIR COOLING

Customer area to have Toshiba Model RAV-SM800 heat pump cassette system with a cooling and heating capacity of 7.0kw and 8.0kw respectively. Condensing unit would be located at the high level on the exterior wall. The unit requires a 16amp single phase supply to be installed by the electrical contractor. The refrigeration service would extend at high level and pass through a wall opening formed by shopfitters.

The branch duct to be extended from cassette unit complete with a boost fan to serving two ceiling mounted air jet diffusers in kitchen. The fan would be controlled by a switch located adjacent to restaurant air conditioning controller. KITCHEN SPOT COOLING


Cooking line in kitchen area to have two extraction canopies each incorporating baffle grease filters and recessed light fittings. The fryer canopy would be 1000x1000 complete with sloping sides. The main canopy would be 3500x1150x500, also with sloping sides. From the two canopies, the extract duct would extend through the side wall at high level and rise externally on the side wall between the corner of the building and the advertising sign. The extract fan and duct silencers would be installed in the vertical and would be supported on cantilever brackets. The extract duct would discharge at high level above the pitched roof. System to be electrically connected the fan with the gas solenoid valve from a power supply installed by the electrical contractor. KITCHEN EXTRACT

KITCHEN FRESH AIR

The fresh air system would serve ceiling mounted diffusers in kitchen area. The fresh air fan, filter assembly and duct work to be installed in open well internal yard area. Branch ducts would pass through roof openings in positions directly above the ceiling mounted grilles. The duct work serving the front grille adjacent to chip fryer to be boxed in at high level against the dividing wall between the kitchen and post mix cupboard. The fresh air fan to be supplied and fit with a speed controller. Electrical connection from a power supply installed by electrical contractor.

An inline fan at high level in the staff W.C with duct connection to grilles in the post mix room and W.C. The air would discharge through a 300x300 wall mounted louvre. STAFF AND W.C EXTRACT

Staff areas to have wall mounted extract fans in each room capable of 10 air changes p/h. The fans would be located at high level and pass through the side wall towards the rear yard area.

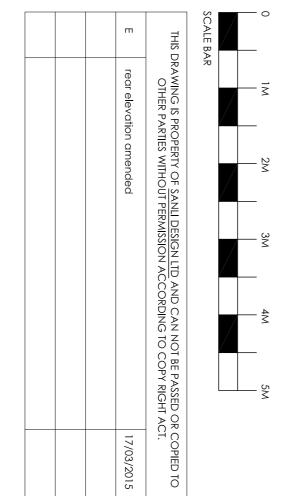

Client:	Title:	Location:	SANLI 28 C. Tel:02086698577
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Location: 259 Station Road	Road	
Harrow		
HAI 2TB		
Title:		
Proposed Layout	yout	
and Elevations	ions	
Client:		
Mrs. Sharmeen Akhtar	Akhtar	
Drawn: Veli Date: Sep 2014	Scale: 1:50	Size:
Job Number: SD/2013/Sharmeen-2	neen-2	REV: